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Drawing Naming Convention:
Code: 10 = Existing, 11 = Proposed
Drawing Type: B = Building, E = Elevation, T = Topographical
Location: B = Basement, C = Sectional Ceiling Plan, FL = Suspended Floor Plan, G = Ground, I = First, S = Side Elevation, M = Mosaic, D = Drainage, AA = Section A-A, Reference to individual dwg. I.D. (e.g. Revision A)

Standard Abbreviations (where applicable):

AB	AIR BRICK	BT	BRICK
ACU	AIR CONDITIONING UNIT	BWT	BOT WATER TANK
AD	ACCESS DRIVE	ETD	EXTERIOR TIE DOWN
AF	ACCESS PANEL	IC	INSPECTION COVER
AV	AIR VALVE	IL	INVEST LEVEL
B	BOLLARD	IR	IRON RAILINGS
BB	BELIEF BEACON	IS	IRON SILL
BE	BEAM HT	IP	LAMP POST
BT	BT COVER	ME	MANGROVE
BS	BOLTS	MK	MARKER POINT
BFL	BRAKE SUPPLY LEVEL	MP	MANHOLE
B/C	BRAKE COVER	PA	PARKING AREA
CB	CABLE TV COVER	PM	PARKING METER
CB	CABLE TV COVER	PT	PARTY WALL
C/B	CLEAR BOARD	RAD	RADIATOR
CC	CHEST CLAMP	RE	REINFORCED CONCRETE
CE	CLEAR EXTERNAL HT	RFV	RADIUM FLOOR VISIT
C-E	CELL TO HEAD HT	RS	ROOF SHEET
CL	COVER LEVEL	RS	ROOF SHEET
C/L	CLEAR LINE	SA	SANITARY
C/P	CERAMIC PAVING	SA	SITE AREA
DB	DOOR BASE HT	SC	SCAFFOLD
DE	DOOR HEAD HT	SL	SOFFIT LEVEL
DEC	DECORATIVE COVER	SO	SOIL
EP	ELECTRIC POLE	STAP	TRAP
EV	EARTH VALVE	STV	SOIL VENT PIPE
EXP	EXTRACTOR FAN	SV	STOP VALVE
FL	FIRE ALARM	SW	STORM WATER
F-C	FLOOR TO CELL HT	TCU	TILE COVER
F-H	FLOOR TO HEAD HT	TEL	TELEPHONE COVER
F-S	FLOOR TO OPENING HT	TEL	TELEPHONE POLE
F-A	FLOOR TO APPEL HT	UTL	UNABLE TO LOCATE
GA	GAS METER	UNL	UNABLE TO LOCATE
GEA	GROUN EXTERNAL AREA	V	VENT
GIA	GROUN INTERNAL AREA	VP	VENT PIPE
GU	GULLY	W	WALLING
GV	GAS VALVE	WM	WATER METER
		WT	WATER TAP

Standard Symbols (where applicable):

2.50	2.00	10.00
FLOOR TO	FLOOR TO	FLOOR LEVEL
STRUCTURAL	STRUCTURAL	RELATIVE TO
CEILING HT	CEILING HT	DATUM
STRUCTURAL WALL	MASONRY WALL	NON-MASONRY WALL

The Survey has been computed about an arbitrary grid & datum. All levels are in metres and relate to datum. It is located at the entrance to Leighton House, Value 10.00m.

Whilst every effort has been made to determine wall materials, no guarantee is given. Materials should be reported as assumed unless verified by a qualified third party.

Visible features in the vicinity of any boundaries, as shown on this survey, may not represent the extent of legally conveyed ownership. All direction arrows indicate UP unless otherwise stated.

Drainage pipe sizes (where shown) have been gauged from the surface (for masonry) and should be reported as approximate only. Clearance dimensions, levels and invert levels should be checked prior to design and construction.

Kerb levels (where shown) should be at the bottom of the channel. Tree appraisals (where shown) should be treated with caution and expert identification is advised.

Rev	Date	By	Description

Client: _____

Project: _____

Drawing Title: _____


EXISTING GROUND FLOOR PLAN

Drawing No: 11024-13-B-G Job No: 11024 Date Surveyed: JUNE 2011

Scale: 1:100@A1 Sheet No: 1 of 1 Status: FINAL

Surveyor: MBH Drawn: MBH Checked: GEO Rev: _____


SCALE BAR 1:100

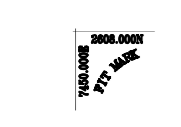

EXISTING COTTAGE GROUND FLOOR PLAN REFER TO DRAWING 11024-13-B-G1 FOR DETAILS



APPROXIMATE DIRECTION OF NORTH

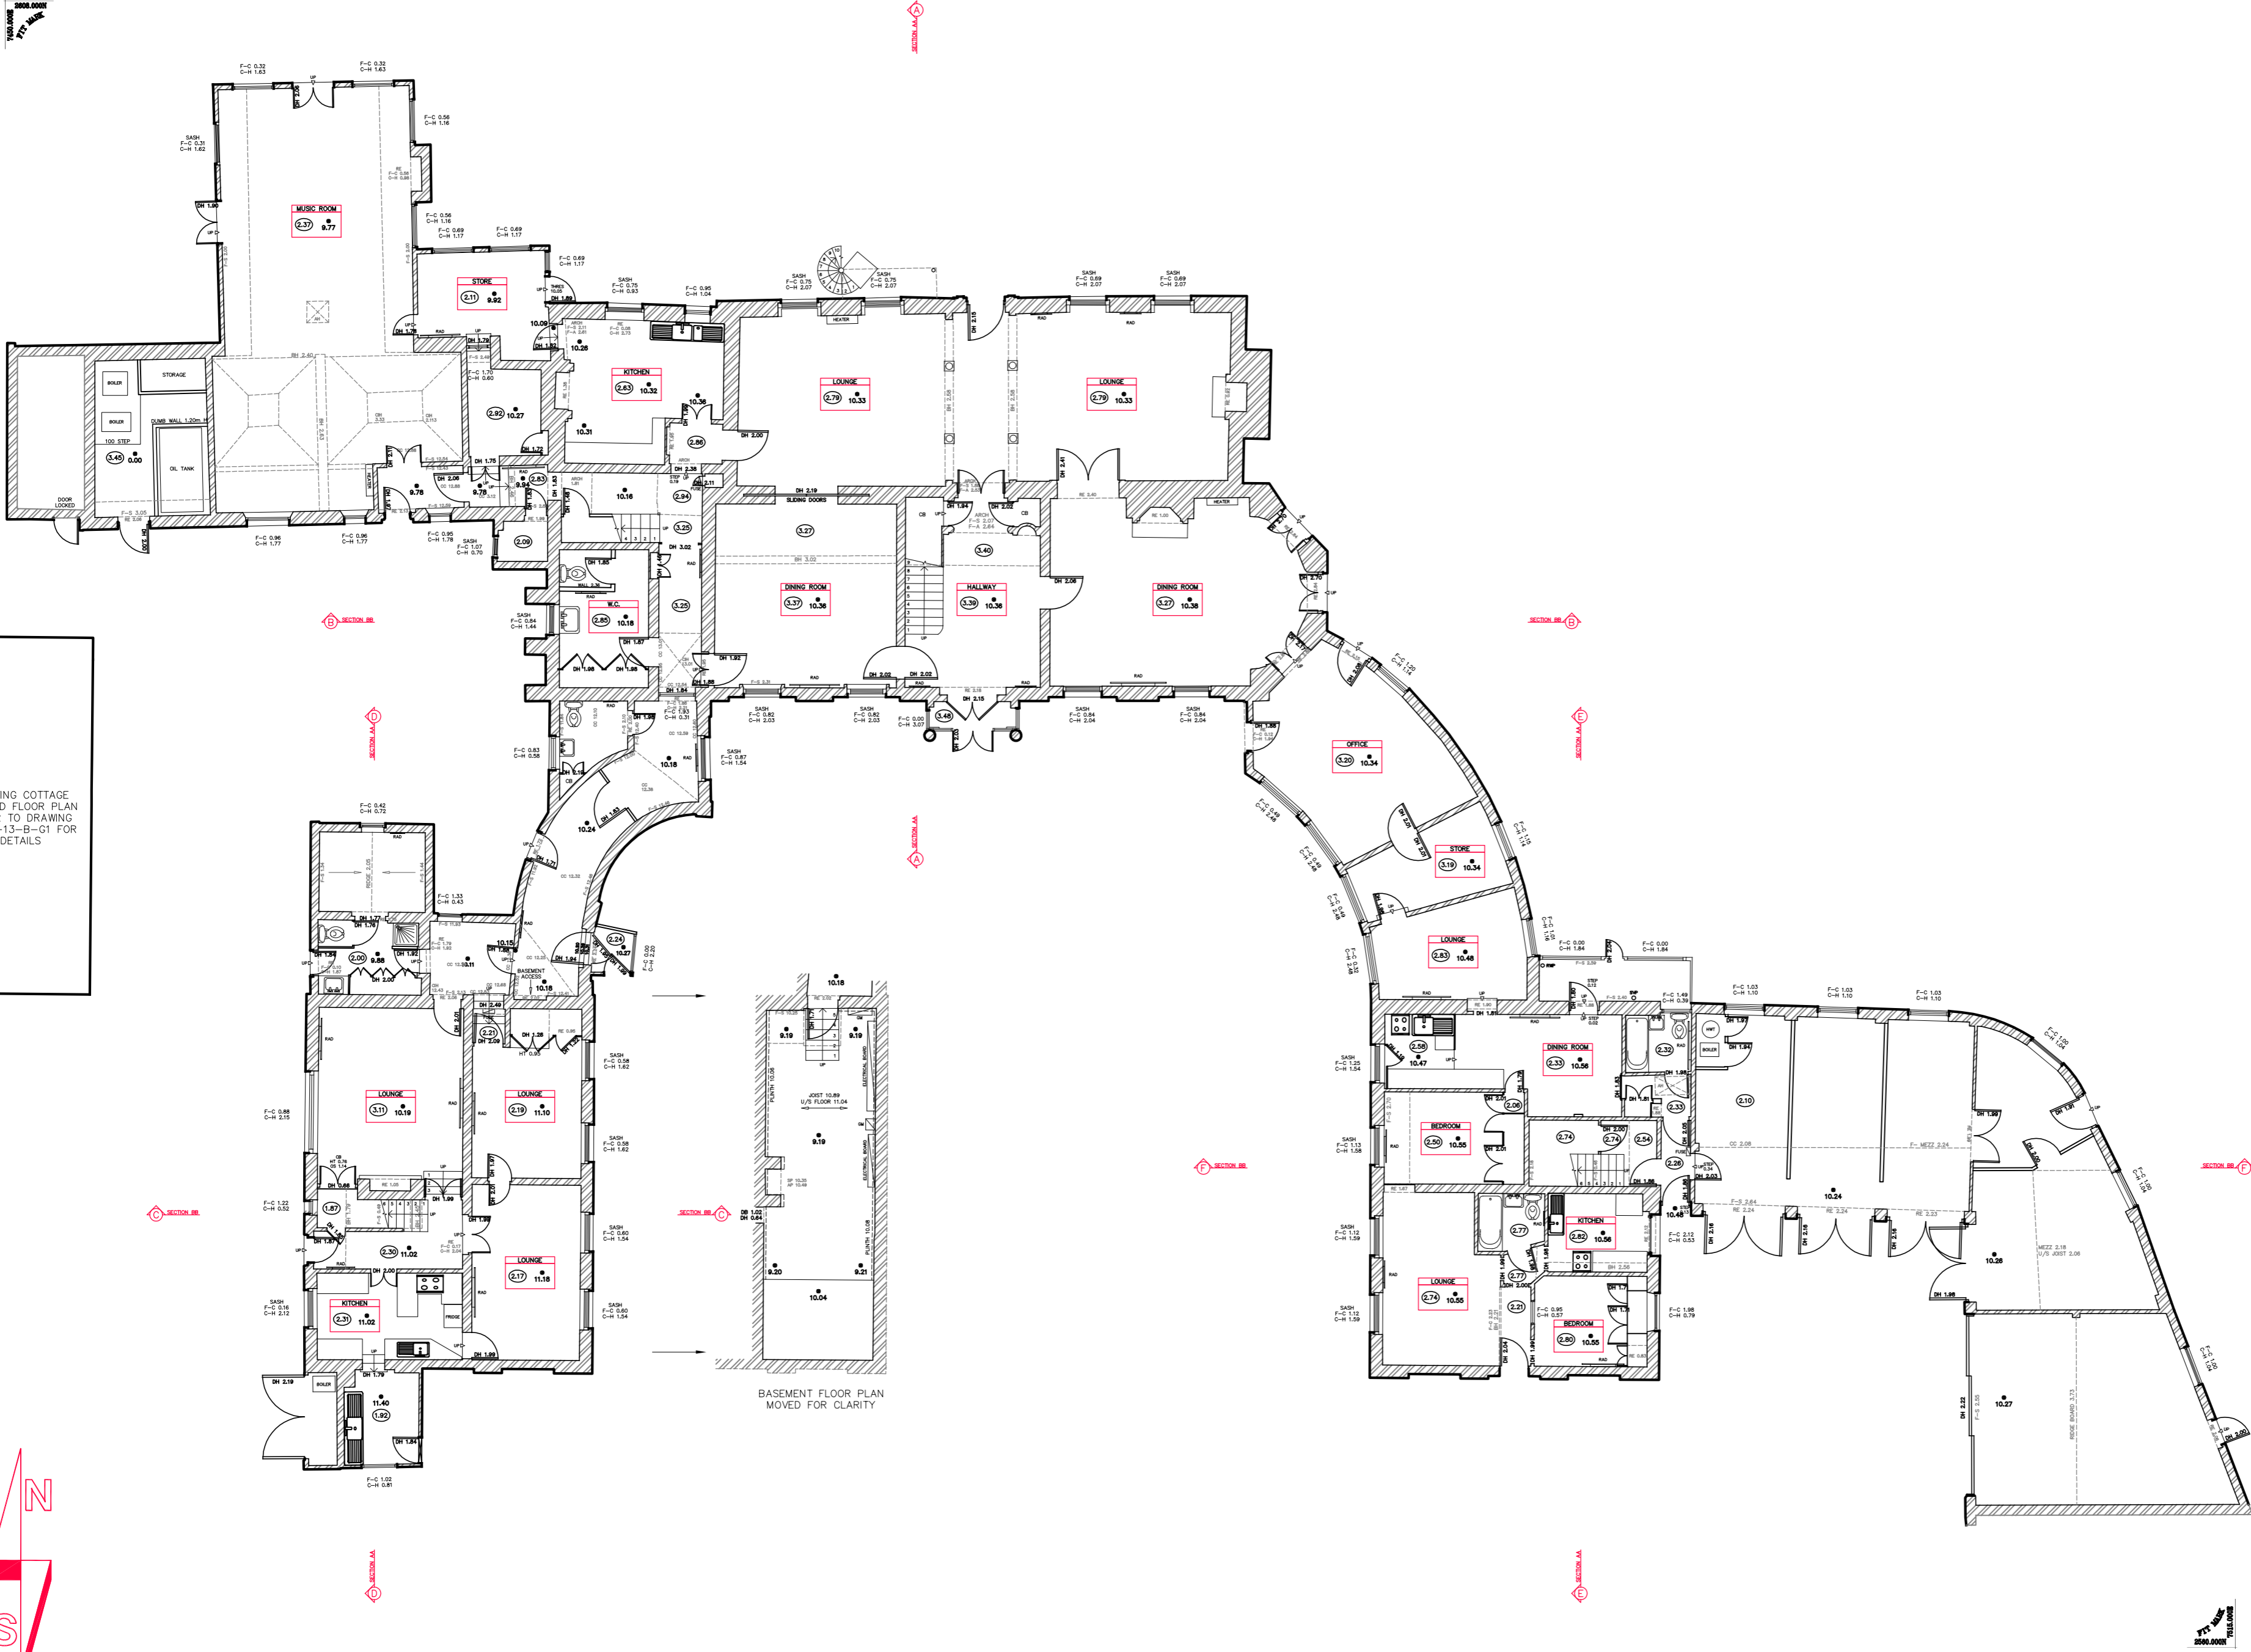

EXISTING GROUND FLOOR PLAN